



(NOT ALL ITEMS MAY APPLY TO THIS PROJECT)										
ABBREVIATIONS			SYMBOLS							
A	G	Q	PLUMBING SYSTEMS			PIPING FITTINGS			MISCELLANEOUS	
A	AIR (COMPRESSED)	G	GAS	GAUZE	QTY	QUANTITY	A	CAP ON END OF PIPE	DRAIN(TYPE AND SIZE AS NOTED ON PLANS)	
AC	AIR ADMITTANCE VALVE	GA	GAL	GALLON	R	REFLECTED CEILING PLAN, REINFORCED CONCRETE PIPE	PIPE UP OR PIPE UP AND DOWN	B	PIPE DOWN	ROOF DRAIN OR OVERFLOW DRAIN
AD	AIR COMPRESSOR	GALV	GENERAL CONTRACTOR	GC	RCP	REFLECTED CEILING PLAN, REINFORCED CONCRETE PIPE	VALVE IN DROP	C	VALVE IN RISE	ROOF DRAIN OR OVERFLOW DRAIN(FROM ABOVE)
ADA	AIR DRYER	GD	GRADE CLEANOUT	GCO	RD	EXISTING ACID WASTE PIPING, BURIED- AW(E)	DIRECTION OF FLOW	D	DIRECTION OF SLOPE DOWN	HOSE BIBB
AFF	ABOVE FINISHED FLOOR	GI	GARAGE DISPOSAL	GI	RE	EXISTING ACID WASTE PIPING, NOT BURIED - AW(E)	CONCENTRIC REDUCER	E	WALL HYDRANT	WALL HYDRANT
AGF	ABOVE FINISHED GRADE	GPD	GREASE INTERCEPTOR	GPD	RECIRC	ACID WASTE, NOT BURIED	ECCENTRIC REDUCER	F	PLUMBING FIXTURE	PLUMBING FIXTURE
ANSI	AMERICAN NATIONAL STANDARDS INSTITUTE	GPM	GLOBE VALVE	GPM	REFG	COLD WATER - CW	TEE UP	G	EXISTING PLUMBING FIXTURE	EXISTING PLUMBING FIXTURE
ASPE	AMERICAN SOCIETY OF PLUMBING ENGINEERS	GPM	GALLONS PER DAY	GPM	RH	EXISTING ACID WASTE PIPING, NOT BURIED - AW(E)	TEE DOWN	H	POINT OF NEW CONNECTION TO EXISTING PIPING	POINT OF NEW CONNECTION TO EXISTING PIPING
ASSE	AMERICAN SOCIETY OF SANITARY ENGINEERING	GPM	GALLONS PER FLUSH	GPM	RM	ACID WASTE, NOT BURIED	UNION	I	LIMIT OF DEMOLITION	LIMIT OF DEMOLITION
AP	ACCESS PANEL	GPM	GALLONS PER HOUR	GPM	RO	EXISTING ACID WASTE PIPING, NOT BURIED - AW(E)	FLANGE	J	PLUMBING DRAWING NOTE REFERENCE	PLUMBING DRAWING NOTE REFERENCE
ARCH	ARCHITECT, ARCHITECTURAL	GPM	GALLONS PER MINUTE	GPM	RPM	ACID WASTE, NOT BURIED	STRAINER WITH BLOWDOWN VALVE	K	DETAIL NUMBER OR PLAN	DETAIL NUMBER OR PLAN
ASME	AMERICAN SOCIETY OF MECHANICAL ENGINEERS	GPM	GREASE TRAP	GPM	RPZ	EXISTING DOMESTIC COLD WATER - CW(E)	GATE VALVE	L	SCHEMATIC	SCHEMATIC
ASTM	AMERICAN SOCIETY FOR TESTING AND MATERIALS	GPM	GATE VALVE, GREASE VENT	GPM	RTU	REDUCED PRESSURE ZONE (BACKFLOW PREVENTER)	GLOBE VALVE	M	STORM DRAIN	STORM DRAIN
AUX	AUXILIARY	GW	GREASE WASTE	GW	RV	ROOF-TOP UNIT	BALL VALVE	N	STANDARD DIMENSIONAL RATIO	STANDARD DIMENSIONAL RATIO
AV	ACID VENT	GWH	GAS WATER HEATER	GWH		RELIEF VALVE	BALANCING VALVE WITH DIFFERENTIAL PRESSURE TAPS	O	SECTION	SECTION
AVTR	ACID VENT THROUGH ROOF						OS&Y VALVE	P	SOLID SPLIT CASE	SOLID SPLIT CASE
AW	ACID WASTE						CHECK VALVE	Q	SOLID SPLIT CASE	SOLID SPLIT CASE
B	B	H	S				BUTTERFLY VALVE	R	SOLID SPLIT CASE	SOLID SPLIT CASE
B	BOILER	HB	HOSE BIBB	SAN			THREE-WAY MODULATING CONTROL VALVE	S	SOLID SPLIT CASE	SOLID SPLIT CASE
BF	BOTTLE FILLER	HC	HANDICAPPED	SCH			SOLENOID VALVE	T	SOLID SPLIT CASE	SOLID SPLIT CASE
BFF	BELLOW FINISH FLOOR	HD	HEAD, HUB DRAIN	SD			PRESSURE REDUCING VALVE	U	SOLID SPLIT CASE	SOLID SPLIT CASE
BFG	BELLOW FINISHED GRADE	HKP	HOUSEKEEPING PAD	SDR			GAS REGULATOR	V	SOLID SPLIT CASE	SOLID SPLIT CASE
BFP	BACKFLOW PREVENTER	HP	HORSEPOWER	SECT			GAS VALVE	W	SOLID SPLIT CASE	SOLID SPLIT CASE
BFV	BUTTERFLY VALVE	HR	HOSE REEL	SH			SPRINKLER FLOOR CONTROL VALVE STATION	X	SOLID SPLIT CASE	SOLID SPLIT CASE
BOF	BOTTOM OF FOOTING	HSC	HORIZONTAL SPLIT CASE	SI			MANUAL AIR VENT	Y	SOLID SPLIT CASE	SOLID SPLIT CASE
BOP	BOTTOM OF PIPE	HT	HEIGHT	SIM			AUTOMATIC AIR VENT	Z	SOLID SPLIT CASE	SOLID SPLIT CASE
BPS	BOTTOM OF STRUCTURE	HTR	HEATER	SK			T&P RELIEF VALVE	AA	SOLID SPLIT CASE	SOLID SPLIT CASE
BWF	BELLOW RAISED FLOOR	HW	HOT WATER	SDS			LINE CLEANOUT/WALL CLEANOUT	BB	SOLID SPLIT CASE	SOLID SPLIT CASE
BT	BATH TUB	HWR	HOT-WATER RETURN	SDR			FLOOR CLEANOUT	CC	SOLID SPLIT CASE	SOLID SPLIT CASE
BTU	BRITISH THERMAL UNIT	HZ	HERTZ	SECT			GRADE CLEANOUT	DD	SOLID SPLIT CASE	SOLID SPLIT CASE
BV	BALL VALVE			SF			PRESSURE GAUGE WITH GAUGE COCK	EE	SOLID SPLIT CASE	SOLID SPLIT CASE
BWV	BACK WATER VALVE			SH			THERMOMETER	FF	SOLID SPLIT CASE	SOLID SPLIT CASE
C	C	I		SI			FLOW VENTURI	GG	SOLID SPLIT CASE	SOLID SPLIT CASE
CB	Celsius	IAPMO	INTERNATIONAL ASSOCIATION OF PLUMBING AND MECHANICAL OFFICIALS	SIM			VACUUM BREAKER	HH	SOLID SPLIT CASE	SOLID SPLIT CASE
CD	CATCH BASIN	ID	INSIDE DIAMETER	SS			VACUUM RELIEF VALVE	II	SOLID SPLIT CASE	SOLID SPLIT CASE
CI	CONDENSATE DRAIN LINE	IE	INVERT ELEVATION	SSD			BACKFLOW PREVENTER	JJ	SOLID SPLIT CASE	SOLID SPLIT CASE
CIRC	CAST IRON	IN	INCH	STD			CIRCULATING PUMP	KK	SOLID SPLIT CASE	SOLID SPLIT CASE
CISPI	CIRCULATING	INSUL	INSULATION	STL			WATER METER/SUB-METER	LL	SOLID SPLIT CASE	SOLID SPLIT CASE
CISPI	CAST IRON SOIL PIPE INSTITUTE	IPC	INTERNATIONAL PLUMBING CODE	STR				MM	SOLID SPLIT CASE	SOLID SPLIT CASE
CFH	CUBIC FEET PER HOUR	IPS	IRON PIPE SIZE	SV			<th>NN</th> <td>SOLID SPLIT CASE</td> <td>SOLID SPLIT CASE</td>	NN	SOLID SPLIT CASE	SOLID SPLIT CASE
CFM	CUBIC FEET PER MINUTE	IW	INDIRECT WASTE	SW			<th>OO</th> <td>SOLID SPLIT CASE</td> <td>SOLID SPLIT CASE</td>	OO	SOLID SPLIT CASE	SOLID SPLIT CASE
CFS	CUBIC FEET PER SECOND	IWH	INSTANTANEOUS WATER HEATER				<th>PP</th> <td>SOLID SPLIT CASE</td> <td>SOLID SPLIT CASE</td>	PP	SOLID SPLIT CASE	SOLID SPLIT CASE
CMU	CONCRETE MASONRY UNIT	IWR	INDIRECT WASTE RECEPTOR				<th>QQ</th> <td>SOLID SPLIT CASE</td> <td>SOLID SPLIT CASE</td>	QQ	SOLID SPLIT CASE	SOLID SPLIT CASE
CO	CENTERLINE						<th>RR</th> <td>SOLID SPLIT CASE</td> <td>SOLID SPLIT CASE</td>	RR	SOLID SPLIT CASE	SOLID SPLIT CASE
COL	CLEAN OUT						<th>SS</th> <td>SOLID SPLIT CASE</td> <td>SOLID SPLIT CASE</td>	SS	SOLID SPLIT CASE	SOLID SPLIT CASE
CONC	CONCENTRIC						<th>TT</th> <td>SOLID SPLIT CASE</td> <td>SOLID SPLIT CASE</td>	TT	SOLID SPLIT CASE	SOLID SPLIT CASE
CONN	CONNECTION						<th>UU</th> <td>SOLID SPLIT CASE</td> <td>SOLID SPLIT CASE</td>	UU	SOLID SPLIT CASE	SOLID SPLIT CASE
CP	CIRCULATING PUMP, CHROME PLATE						<th>VV</th> <td>SOLID SPLIT CASE</td> <td>SOLID SPLIT CASE</td>	VV	SOLID SPLIT CASE	SOLID SPLIT CASE
CPVC	CHLORINATED POLYVINYL CHLORIDE						<th>WW</th> <td>SOLID SPLIT CASE</td> <td>SOLID SPLIT CASE</td>	WW	SOLID SPLIT CASE	SOLID SPLIT CASE
CW	COLD WATER						<th>XX</th> <td>SOLID SPLIT CASE</td> <td>SOLID SPLIT CASE</td>	XX	SOLID SPLIT CASE	SOLID SPLIT CASE
CWP	COLD WORKING PRESSURE						<th>YY</th> <td>SOLID SPLIT CASE</td> <td>SOLID SPLIT CASE</td>	YY	SOLID SPLIT CASE	SOLID SPLIT CASE
D	D	L	T				<th>ZZ</th> <td>SOLID SPLIT CASE</td> <td>SOLID SPLIT CASE</td>	ZZ	SOLID SPLIT CASE	SOLID SPLIT CASE
DBP	DOMESTIC BOOSTER PUMP	L	LAVATORY LENGTH	TCO			<th>AA</th> <td>SOLID SPLIT CASE</td> <td>SOLID SPLIT CASE</td>	AA	SOLID SPLIT CASE	SOLID SPLIT CASE
DC	DOVSPOUT COVER	LAV	LAVATORY	TD			<th>BB</th> <td>SOLID SPLIT CASE</td> <td>SOLID SPLIT CASE</td>	BB	SOLID SPLIT CASE	SOLID SPLIT CASE
DCVA	DOUBLE CHECK VALVE ASSEMBLY	LF	LINEAR FEET	TDH			CC	SOLID SPLIT CASE	SOLID SPLIT CASE	
DDCVA	DOUBLE DETECTOR CHECK VALVE ASSEMBLY	LP	LOW PRESSURE	TOL			DD	SOLID SPLIT CASE	SOLID SPLIT CASE	
DF	DRINKING FOUNTAIN	LPG	LIQUEFIED PETROLEUM GAS	TMV			EE	SOLID SPLIT CASE	SOLID SPLIT CASE	
DFU	DRAINAGE FIXTURE UNIT	LT	LINT, LINT TRAP	TOB			FF	SOLID SPLIT CASE	SOLID SPLIT CASE	
DI	DEIONIZED	LVL	LEVEL	TOF			GG	SOLID SPLIT CASE	SOLID SPLIT CASE	
DIA	DIA			TP			HH	SOLID SPLIT CASE	SOLID SPLIT CASE	
DIM	DIMENSION			TS			II	SOLID SPLIT CASE	SOLID SPLIT CASE	
DISC	DISCONNECT			TD			JJ	SOLID SPLIT CASE	SOLID SPLIT CASE	
DIV	DIV DOWNSPOUT NOZZLE			TDH			KK	SOLID SPLIT CASE	SOLID SPLIT CASE	
DS	DOWNSPOUT			TOL			LL	SOLID SPLIT CASE	SOLID SPLIT CASE	
DW	DISHWASHER			TMV			MM	SOLID SPLIT CASE	SOLID SPLIT CASE	
DWG	DRAWING			TOB			NN	SOLID SPLIT CASE	SOLID SPLIT CASE	
DWV	DRAINAGE WASTE AND VENT			TOF			OO	SOLID SPLIT CASE	SOLID SPLIT CASE	
E	E	N	V	TP			PP	SOLID SPLIT CASE	SOLID SPLIT CASE	
ECC	ECCENTRIC	N.C.	NORMALLY CLOSED	V			QQ	SOLID SPLIT CASE	SOLID SPLIT CASE	
EDF	ELECTRIC DRINKING FOUNTAIN	N.F.P.A.	NATIONAL FIRE PROTECTION ASSOCIATION	VAC			RR	SOLID SPLIT CASE	SOLID SPLIT CASE	
EEW	EMERGENCY EYEWASH	NIC	NOT IN CONTRACT	VB			TT	SOLID SPLIT CASE	SOLID SPLIT CASE	
EL	ELEVATION	N.O.	NORMALLY OPEN	VFD			UU	SOLID SPLIT CASE	SOLID SPLIT CASE	
ES	EMERGENCY SHOWER	N.P.T.	NORMALLY OPEN	VP			VV	SOLID SPLIT CASE	SOLID SPLIT CASE	
ESP	ELEVATOR SUMP PUMP	NTS	NOT TO SCALE	VS			WW	SOLID SPLIT CASE	SOLID SPLIT CASE	
ET	EXPANSION TANK			VTR			XX	SOLID SPLIT CASE	SOLID SPLIT CASE	
ETR	EXISTING TO REMAIN						YY	SOLID SPLIT CASE	SOLID SPLIT CASE	
EWC	ELECTRIC WATER COOLER						ZZ	SOLID SPLIT CASE	SOLID SPLIT CASE	
EWH	ELECTRIC WATER HEATER						AA	SOLID SPLIT CASE	SOLID SPLIT CASE	
F	F	O	W				BB	SOLID SPLIT CASE	SOLID SPLIT CASE	
FBO	FARENNHIT, FIRE FURNISHED BY OTHERS	OC	ON CENTER	W			CC	SOLID SPLIT CASE	SOLID SPLIT CASE	
FCO	FLOOR CLEAN OUT	OD	OUTSIDE DIAMETER, OVERFLOW DRAIN	W/			DD	SOLID SPLIT CASE	SOLID SPLIT CASE	
FCV	FLOOR CONTROL VALVE	OS	OUTSIDE STEM AND YOKE	W/O			EE	SOLID SPLIT CASE	SOLID SPLIT CASE	
FD	FLOOR DRAIN	OZ	OUNCES	WB			FF	SOLID SPLIT CASE	SOLID SPLIT CASE	
FDC	FIRE DEPARTMENT CONNECTION			WC			GG	SOLID SPLIT CASE	SOLID SPLIT CASE	
FE	FIRE EXTINGUISHER CABINET			WCO			HH	SOLID SPLIT CASE	SOLID SPLIT CASE	
PH	FE			WH			II	SOLID SPLIT CASE	SOLID SPLIT CASE	
FHO	Fire hose cabinet			WHA			JJ	SOLID SPLIT CASE	SOLID SPLIT CASE	
FHR	Fire hose rack			WM			KK	SOLID SPLIT CASE	SOLID SPLIT CASE	
FHV	Fire hose valve			WMB			LL	SOLID SPLIT CASE	SOLID SPLIT CASE	
FIXT	Fixture			WOG			MM	SOLID SPLIT CASE	SOLID SPLIT CASE	

SITE UTILITY NOTES

- REFER TO CIVIL DRAWINGS FOR BUILDING FINISHED FLOOR ELEVATION(S).
- ALL INVERT ELEVATIONS INDICATED ARE RELATIVE TO THE FINISHED FLOOR ELEVATION OF THE BUILDING SLAB AT THEIR RESPECTIVE LOCATIONS, UNLESS SPECIFICALLY NOTED OTHERWISE.
- ROLL-DOWN AS NECESSARY AND PROVIDE PIPE, FITTINGS, AND ADAPTERS AS REQUIRED TO MAKE PROPER CONNECTIONS TO SITE UTILITY LINES.
- PROVIDE SCHEDULE 40 SOLID WALL PVC SLEEVES FOR ALL INCOMING GAS SERVICE PIPING TO BE ROUTED BELOW CONCRETE, ASPHALT, OR PAVING. SLEEVES SHALL BE NO SMALLER THAN TWO TIMES THE DIAMETER OF THE GAS PIPING TO BE SERVED. PROVIDE 4'0" X 4'0" TEMPORARY LEAVE-OUTS IN THE PAVING AT ALL CHANGES IN DIRECTION ALONG THE ROUTE OF THE SLEEVING. ENSURE ALL SLEEVES ARE MAINTAINED FREE FROM DIRT AND DEBRIS, CAPPED AT BOTH ENDS, AND CLEARLY LABELED. FILL LEAVE-OUTS TO MATCH FINISHED CONDITIONS. THESE GENERAL GUIDELINES SHALL NOT SUPERCEDE THE LOCAL GAS PROVIDER'S REQUIREMENTS, WHICH SHALL GOVERN THE INSTALLATION OF ALL SLEEVING.
- FIELD COORDINATE/CONFIRM THE ROUTING AND INSTALLATION OF GAS SERVICE PIPING WITH THE LOCAL UTILITY PROVIDER PRIOR TO ANY SITE PAVING WORK. MAKE ADJUSTMENTS AS REQUIRED.

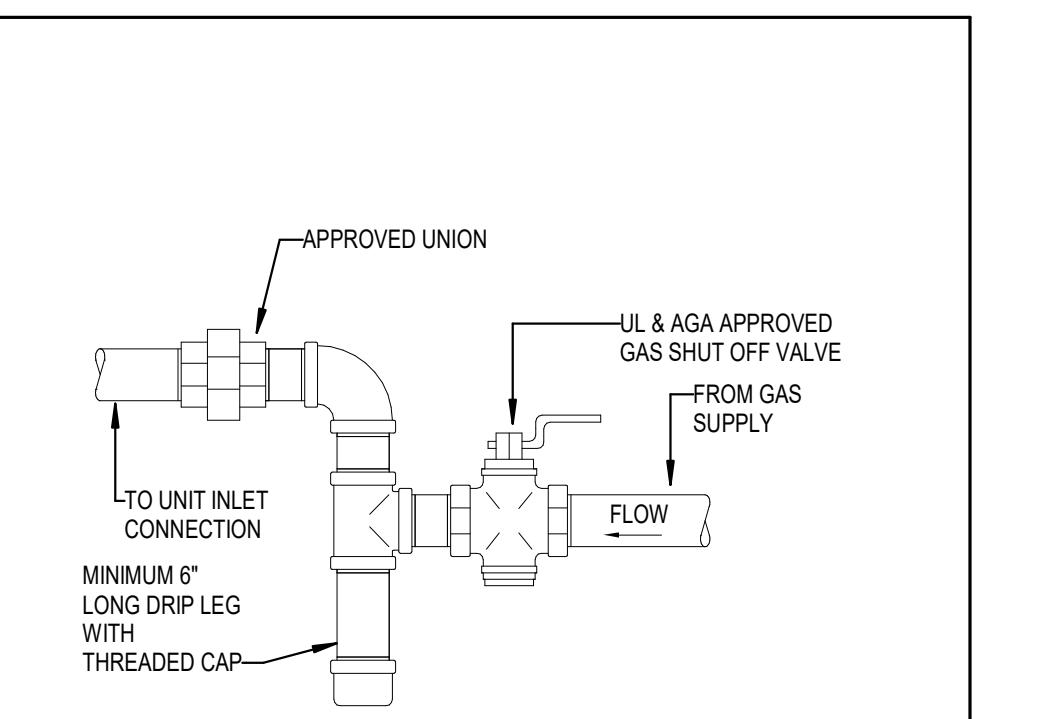

1 | GAS CONNECTION TO EQUIPMENT - FIRE DEPT.

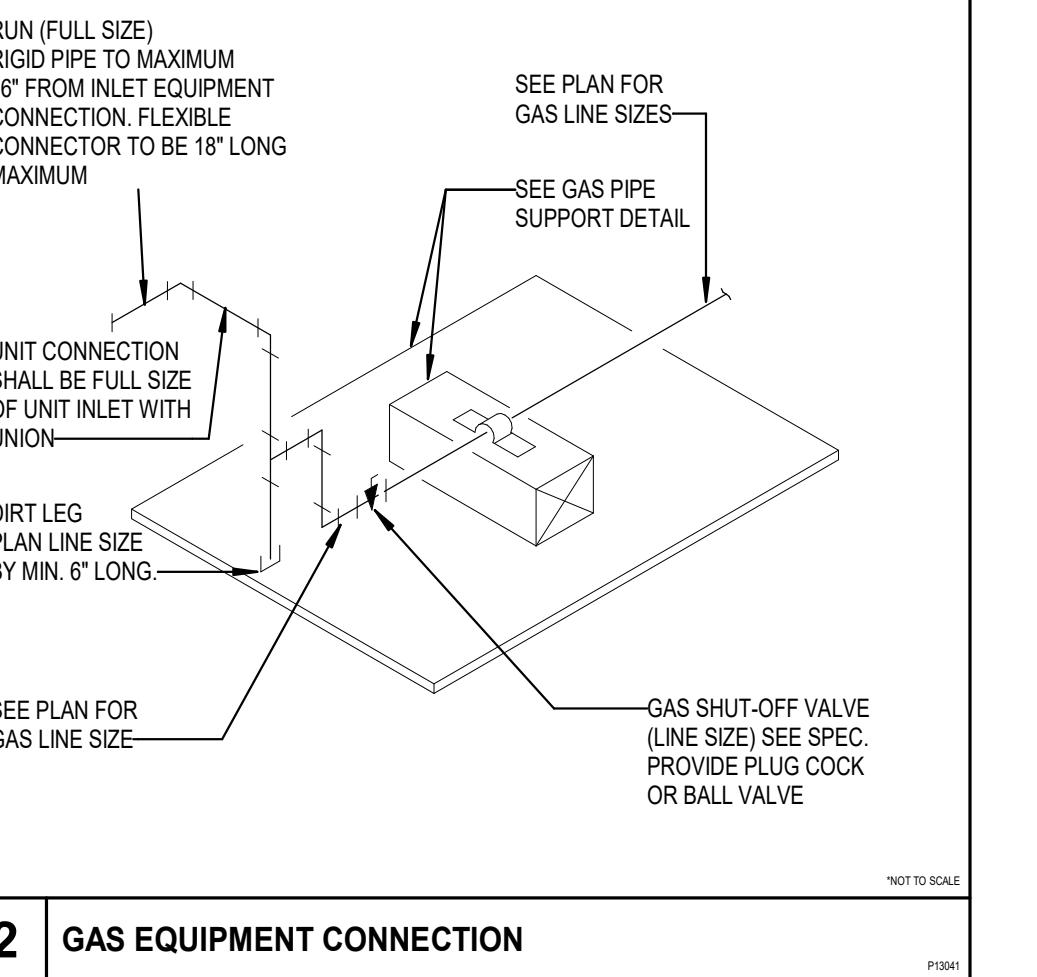

2 | GAS EQUIPMENT CONNECTION

GENERAL WORK NOTES

- ALL WORK METHODS, AND INSTALLATIONS INVOLVED IN THE PLUMBING DESIGN SHALL BE IN ACCORDANCE WITH THE PREVAILING CODE AND INSPECTION REGULATIONS AND ALL OTHER OFFICIALS HAVING JURISDICTION.
- CONTRACTOR SHALL FIELD VERIFY EXACT LOCATIONS, ELEVATIONS, DIRECTION OF FLOW, PIPE SIZES & CAPACITIES, AND PIPE MATERIAL & CONDITION AT PROPOSED POINTS OF CONNECTION WITH EXISTING BUILDING PLUMBING LINES AND SITE CIVIL LINES PRIOR TO INSTALLATION OF ANY NEW WORK. MODIFY/REPLACE EXISTING PIPING IF ANAS AS REQUIRED TO ENSURE PROPER CONNECTIONS. ONLY CONNECT NEW LINES TO SUITABLE EXISTING LINES OF EQUAL OR GREATER SIZE.
- COORDINATE ROUTING OF BURIED PIPING WITH COLUMN FOOTINGS, GRADE BEAMS, UNDERGROUND UTILITIES, AND ALL OTHER SUB-SURFACE BUILDING ELEMENTS. MAKE ADJUSTMENTS AS REQUIRED AND ADVISE ARCHITECT/ENGINEER OF ANY GRADING CONFLICTS PRIOR TO COMMENCING INSTALLATION.
- CONTRACTOR SHALL FIELD COORDINATE LOCATIONS AND ELEVATIONS OF ALL PLUMBING PIPING WITH OTHER TRADES PRIOR TO INSTALLATION. WHERE RELOCATIONS OF NEW WORK ARE REQUIRED TO CORRECT CONFLICTS WITH OTHER TRADES IT SHALL BE DONE AT NO ADDITIONAL COST TO OWNER.
- CONTRACTOR SHALL BE RESPONSIBLE FOR FIELD COORDINATING ALL PLUMBING PIPING SLEEVE LOCATIONS WITH ALL OTHER TRADES PRIOR TO INSTALLATION OF ANY PIPING OR SUPPORTS.
- RENOVATIONS SITE INSPECTIONS. CONTRACTOR SHALL VISIT THE SITE OF WORK PRIOR TO SUBMITTING A BID AND THOROUGHLY FAMILIARIZE HIMSELF WITH THE EXISTING CONDITIONS AND EXACT NATURE OF WORK. SUBMISSION OF A BID ACKNOWLEDGES FULL RESPONSIBILITY FOR FURNISHING A COMPLETE AND FUNCTIONAL SYSTEM. NO CHANGES IN THE CONTRACT WILL BE MADE TO ACCOMMODATE OR ALLOW EXTRA FUNDS FOR ANY OMISSION WHICH RESULTS FROM FAILURE TO MAKE SUCH A THOROUGH EXAMINATION. NOTE THAT FOR GRAPHICAL CLARITY, ALL EXISTING PIPING TO REMAIN OR BE ABANDONED IN PLACE MAY NOT BE SHOWN ON THE FLOOR PLANS.

QTY	GAS LOAD DEMAND (EXISTING)	CFH
1	APPLIANCES/EQUIPMENT @ 40Z	875
1	EMERGENCY GENERATOR (EXIST.)	1,728
	TOTAL - GAS LOAD (EXISTING)	2,603
	TOTAL DEVELOPED LENGTH 0'-0"	

QTY	GAS LOAD DEMAND (NEW)	CFH
1	APPLIANCES/EQUIPMENT @ 40Z	875
1	EMERGENCY GENERATOR @ 5 PSI (NEW)	2,188
	TOTAL - GAS LOAD (EXISTING)	3,063
	TOTAL DEVELOPED LENGTH 0'-0"	

GAS PRESSURE REGULATORS					
MARK	INLET PRESSURE (PSI)	OUTLET PRESSURE (IN...)	CFH	MANUFACTURER	MODEL NUMBER
GPR-1	5	11	3,063	MAXITROL	325 SERIES

NOTE:

- COORDINATE FINAL REGULATOR SELECTIONS WITH FINAL EQUIPMENT BEING PROVIDED. MAKE ADJUSTMENTS AS REQUIRED.
- ALL GAS PRESSURE REGULATORS SHALL MEET THE REQUIREMENTS OF ANSI Z21.80 (NFPA 54 5.8.2.).
- REGULATORS LOCATED INDOORS SHALL NOT BE INSTALLED CONCEALED OR ABOVE A CEILING. ALL INDOOR REGULATORS MUST BE LOCATED BELOW FINISHED CEILINGS OR IN EXPOSED AREAS.
- NATURAL GAS PIPING BELOW GRADE AND OUTSIDE THE BUILDING SHALL BE YELLOW POLYETHYLENE WITH SOCKET HEAT FUSION WELD FITTINGS.
- REGULATORS LOCATED INDOORS SHALL NOT BE INSTALLED CONCEALED OR ABOVE A CEILING. ALL INDOOR REGULATORS MUST BE LOCATED BELOW FINISHED CEILINGS OR IN EXPOSED AREAS.
- NATURAL GAS PIPING BELOW GRADE AND OUTSIDE THE BUILDING SHALL BE YELLOW POLYETHYLENE WITH SOCKET HEAT FUSION WELD FITTINGS.
- NATURAL GAS PIPING ABOVE GRADE SHALL BE SEAMLESS SCHEDULE 40 BLACK STEEL.
- PROVIDE REGULATOR VENT LINE FOR EACH REGULATOR INDEPENDENTLY AND ROUTE EACH LINE FULL SIZE TO THE OUTDOORS. (HIDE CELL IF SCHEDULING VENTLESS/VENT LIMITING PRESSURE REGULATORS)

 NEW FIRE STATION #12 CY-FAIR
 VOLUNTEER DEPARTMENT HARRIS
 COUNTY EMERGENCY SERVICES NO. 9
TBPE Firm
Registration No. 2234DATE:
07/31/24DRAWN BY:
AuthorCHECKED BY:
CheckerPROJECT NUMBER
Project NumberSHEET TITLE:
PLUMBING GENERAL NOTES

SHEET NUMBER:

P0.11

ABBREVIATIONS	ELECTRICAL SYMBOLS		GENERAL NOTES: A. NOT ALL SYMBOLS SHOWN ON THIS SYMBOL LIST ARE USED IN THE CONTRACT DOCUMENTS.
MOTORS AND CONTROLS	RACEWAYS AND WIRING	MISCELLANEOUS	
AC ALTERNATING CURRENT AF AMPERE FUSE, AMPERE FRAME AFC ABOVE FINISHED CEILING AFF ABOVE FINISHED FLOOR AFG ABOVE FINISHED GRADE AIC AMPERE INTERRUPT CAPACITY AL ALUMINUM AM AMMETER AMP AMPLIFIER ANN ANNUNCIATOR ASC AMPERES SHORT CIRCUIT AT AMPERE TRIP RATING ATS AUTOMATIC TRANSFER SWITCH AUX AUXILIARY BKR BREAKER BLDG. BUILDING C CONDUIT, CELSIUS CKT CIRCUIT CLG CEILING CONT. CONTINUOUS CONTINUATION CONTR. CONTRACTOR CT CURRENT TRANSFORMER/COOLING TOWER CU COPPER DAS DISTRIBUTED ANTENNA SYSTEM DC DIRECT CURRENT DISC DISCONNECT DP DISTRIBUTION PANEL DPDT DOUBLE-POLE, DOUBLE-THROW DPST DOUBLE-POLE, SINGLE-THROW DWG DRAWING ELEV. ELEVATOR EPF EMERGENCY POWER OFF ERRC EMERGENCY RESPONDER RADIO COVERAGE SYSTEM FA FIRE ALARM FF FURNITURE FEED FLA FULL LOAD AMPS FTL FEED-THRU LUGS GA GAUGE GEN GENERATOR GND GROUND GTD GENERATOR TRANSFER DEVICE IG INDUCED GROUND LF LINEAR FEET LTG LIGHTING LV LOW VOLTAGE LVL LEVEL MAX. MAXIMUM MC METAL CLAD CABLE MCA MINIMUM CIRCUIT AMPS MCB MAIN CIRCUIT BREAKER MCCB MOLDED CASE CIRCUIT BREAKER MD MOTORIZED DAMPER MDP MAIN DISTRIBUTION PANEL MFR MANUFACTURER MIC MICROPHONE MIN. MINIMUM MLO MAIN LUGS ONLY MOPC MAXIMUM OVER-CURRENT PROTECTION MSB MAIN SWITCHBOARD N3R NEMA 3R N4X NEMA 4X N.C. NORMALLY CLOSED NEC NATIONAL ELECTRICAL CODE NF NON-FUSED NFS NON-FUSED SWITCH NIC NOT IN CONTRACT NL NIGHT LIGHT N.O. NORMALLY OPEN NO. NUMBER NTS NOT TO SCALE PH PHASE POS POINT OF SALE QTY QUANTITY RCP REFLECTED CEILING PLAN RCPT RECEPTEACLE RE REFERENCE, REFER SF SQUARE FOOT SIM SIMPLIFIED SKVA STARTING KILOVOLT-AMPS SPD SURGE PROTECTION DEVICE SPDT SINGLE-POLE DOUBLE-THROW SPST SINGLE-POLE, SINGLE-THROW SPEC SPECIFICATION SOFT SOFT ST SHUNT TRIP SWB SWITCHBOARD TL TWIST-LOCK TOC TOP OF CURE TOS TOP OF STEEL TR TAMPER RESISTANT RECEPTACLE TV TELEVISION TYP TYPICAL UG UNDERGROUND UNO UNLESS NOTED OTHERWISE UPS UNINTERRUPTIBLE POWER SYSTEM VFD VARIABLE FREQUENCY DRIVE WP WEATHERPROOF WT WATERTIGHT, WEIGHT W/SF WATTS PER SQUARE FOOT XFMR TRANSFORMER MANY ABBREVIATIONS NOT LISTED MAY BE FOUND IN THE NATIONAL ELECTRIC CODE, OR IN THE INTERNATIONAL AND UNIFORM CODES	MOTORS AND CONTROLS \$M MOTOR RATED SWITCH WITH THERMAL OVERLOADS S SINGLE OR THREE PHASE MOTOR NUMBER INDICATES HORSE POWER ELECTRIC DUCT HEATER DISCONNECT (SAFETY) SWITCH "2003/150" DENOTES AMPERES/POLE/FUSE. "NF" DENOTES NON-FUSED. "N3R" DENOTES NEMA 3R B BREAKER ENCLOSED CIRCUIT BREAKER. "2003/150" DENOTES AMPERES/POLE/TRIP. MOTOR STARTER FURNISHED BY DIVISION 23 AND INSTALLED BY DIVISION 26 COMBINATION DISCONNECT (SAFETY) SWITCH AND MOTOR STARTER. "30/3150" DENOTES AMPERES/POLES/FUSE/STARTER SIZE. "NF" DENOTES NON-FUSED. FURNISHED BY DIVISION 23 AND INSTALLED BY DIVISION 26. VARIABLE FREQUENCY DRIVE PROVIDED BY DIVISION 23 AND INSTALLED BY DIVISION 26. EMERGENCY POWER OFF BUTTON. RECEPTACLES AND OUTLETS ALL RECEPTACLES SHALL BE MOUNTED 18" ABOVE FINISHED FLOOR TO CENTER OF DEVICE UNLESS NOTED OTHERWISE. REFER TO SPECIFICATIONS AND DRAWINGS FOR ADDITIONAL REQUIREMENTS. ABBREVIATIONS APPLICABLE TO RECEPTACLES: "GFCI" GROUND FAULT INTERRUPTER "WP" WEATHERPROOF "IG" INDUCED GROUND "TR" TAMPER RESISTANT "USB" RECEPTACLE WITH USB CHARGING PORTS "AC" ABOVE COUNTER MOUNTING "UC" UNDER COUNTER MOUNTING "H" HORIZONTALLY ORIENTED RECEPTACLE SIMPLEX WALL RECEPTACLE, NEMA 5-20R, 20A, 125V. DUPLEX WALL RECEPTACLE, NEMA 5-20R, 20A, 125V. SHADED INDICATES SPLIT-WIRED. FOURPLEX (QUADRUPLEXP) RECEPTACLE DUPLEX RECEPTACLE (PEDESTAL MOUNTED) CONTROLLED WALL RECEPTACLE. DUPLEX, SPLIT-WIRED QUAD, SEPARATELY WIRED UNDER A COMMON COVERPLATE. POWER DEVICE REED IN COLOR, ON EMERGENCY POWER CIRCUIT CEILING RECEPTACLE/QUAD, EMERGENCY POWER SYMBOL MAY APPLY SPECIAL RECEPTACLE, NEMA CONFIGURATION PER PLAN OR EQUIPMENT TV ROUGH-IN: 3-GANG RECESSED TV BOX, CONTAINING 1 DUPLEX RECEPTACLE, 1 GANG FOR AV, 1 GANG FOR DATA FLOOR BOX OR POKE THRU: POKE-THRU'S WHERE IN SUSPENDED SLABS, RECESSED IN FOUNDATION WHERE SLAB ON GRADE FLUSH ELECTRICAL FLOOR OUTLET, REFER TO FLOOR BOX SCHEDULE, FIRE RATED POKE-THROUGH SCHEDULE AND KEYED NOTES. DROP CORD WITH SIMPLEX RECEPTACLE UNLESS OTHERWISE NOTED CORD REEL WITH DUPLEX RECEPTACLE UNLESS OTHERWISE NOTED JUNCTION BOX "MD" INDICATES POWER CONNECTION TO SERVE MOTOR DAMPER "HD" INDICATES POWER CONNECTION TO SERVE HAND DRYER "FV" INDICATES POWER CONNECTION TO SERVE FLUSH VALVES PULL BOX (OVER 4" SQUARE) BELL/BUZZER/CHIME PUSH BUTTON/DOOR BELL/START-STOP POWER POLE POINT OF DIRECT CONNECTION TO EQUIPMENT CLOCK RECEPTACLE SHALL BE MOUNTED 12" BELOW FINISHED CEILING. (2) DENOTES DOUBLE SIDED CLOCK. LIGHTING LETTER(S) DENOTE TYPE- SEE LIGHTING FIXTURE SCHEDULE FOR ADDITIONAL INFORMATION. 2 X 4' 2 X 2' 1' X 4' 1' X 2' 1' X 1' STRIP LIGHTING FIXTURE. ROUND DOWNLIGHT FIXTURE. SQUARE DOWNLIGHT FIXTURE. WALL MOUNTED LIGHTING FIXTURE. TRACK LIGHTING FIXTURE, MOUNTED AS SHOWN ON LIGHTING FIXTURE SCHEDULE. CEILING MOUNTED EXIT SIGN; ARROWS AS INDICATED. SHADeD AREA DENOTES FACE. WALL MOUNTED EXIT SIGN; ARROWS AS INDICATED. SHADeD AREA DENOTES FACE. EMERGENCY WALL MOUNTED LIGHTING FIXTURE. BATTERY OPERATED UNLESS NOTED OTHERWISE. SITE LIGHTING FIXTURE. HATCHING PATTERNS BELOW SHALL APPLY TO ALL LIGHTING FIXTURE SYMBOLS. NL EMERGENCY LIGHT FIXTURE WITH BATTERY PACK. PROVIDE WITH UNSWITCHED HOT FOR LOSS OF VOLTAGE AND CHARGING (SAME CIRCUIT AS NORMAL POWER LIGHTING). FIXTURES SHALL BE WIRED IN A MANNER AS TO ALLOW SWITCHING OF FIXTURES WITHOUT DISCHARGING THE EMERGENCY BATTERY. BATTERY PACK IS TO ONLY OPERATE IN THE EVENT OF A POWER OUTAGE. "NL" NIGHT LIGHT ON UNSWITCHED 24HR OPERATION EM CIRCUIT LIGHT FIXTURE ON LIFE SAFETY BRANCH CIRCUIT. GENERATOR TRANSFER DEVICES REQUIRED (UL1008 OR UL324) PROVIDE UNSWITCHED HOT, NEUTRAL AND GROUND FOR ALL LIFE SAFETY LIGHTING ORIGINATING FROM THE LIFE SAFETY CIRCUIT SHOWN. CRITICAL OPERATIONS LIGHTING ORIGINATING FROM THE CRITICAL CIRCUIT INDICATED. HATCHING AS INDICATED. HATCHING TYPICAL FOR ALL CRITICAL BRANCH LIGHT FIXTURES	RACEWAYS AND WIRING \$ CAP AND STAKE CONDUIT CONCEALED IN WALL OR CEILING UNDERGROUND, UNDERSLAB, CONCEALED ROUTING OHE OVERHEAD ELECTRIC PRIMARY UTILITY POWER LINE CONDUIT UP/DOWN HASH MARKS INDICATE NUMBER OF CONDUCTORS. LEFT TO RIGHT: PHASE/NEUTRAL/GROUND/ISOLATED GROUND. UNLESS NOTED OTHERWISE. 1LA-2,6 HOMERUN TO PANEL WITH CIRCUIT NUMBER(S) AS INDICATED. PART/SHARED CIRCUIT HOMERUN TO PANEL. (ON)LA-6 TELECOMMUNICATIONS CABLE TRAY SHALL BE CONCEALED ABOVE ACCESSIBLE CEILING UNLESS OTHERWISE NOTED. ELECTRICAL EQUIPMENT WATER FLOW SWITCH SUPEROVISORY SWITCH SMOKE DETECTOR - MULTI CRITERIA DETECTOR SMOKE DETECTOR - SSB INDICATES INTEGRAL SOUNDER BASE. "D" INDICATES DUCT TYPE. "R" INDICATES 120 VOLT RESIDENTIAL TYPE HEAT DETECTOR BEAM DETECTOR TRANSMITTER, HIGH IN CEILING WALL DIRECT LINE OF SIGHT. BEAM DETECTOR RECEIVER, HIGH IN CEILING WALL DIRECT LINE OF SIGHT. FIRE ALARM SPEAKER STROBE / CEILING MOUNTED FIRE ALARM SPEAKER / CEILING MOUNT. MAGNETIC DOOR HOLDER AUXILIARY CONTROL RELAY FIRE FIGHTER HANDSET FIRE ALARM PULL STATION +42" AFF FIREMAN'S TELEPHONE JACK +42" AFF AUDIO VISUAL FIRE ALARM HORN STROBE +80" AFF- 15/75cd U.N.O. VISUAL FIRE ALARM (STROBE) CEILING MOUNT - 15/75cd U.N.O. AUDIO FIRE ALARM HORN +80" AFF FIRE ALARM CONTROL PANEL REMOTE FIRE ALARM ANNUNCIATOR PANEL REMOTE POWER SUPPLY FOR AUDIO/VISUAL FIRE ALARM DEVICES. FIRE SMOKE DAMPER REMOTE LED INDICATOR LIGHT COMMUNICATIONS DEFAULT ELEVATION (UNLESS INDICATED OTHERWISE) TO CENTER OF ROUGH-IN: 18" ABOVE FINISHED FLOOR (AFF) DATA/COMM/ROUGH-IN: CONDUIT TO PLENUM AND BOX ONLY HS HDS SCHOOL INTERCOMMUNICATION SYSTEM HANDSET. DEFAULT ELEVATION (UNLESS INDICATED OTHERWISE) TO CENTER OF ROUGH-IN: 42" AFF VC VOLUME CONTROL - WALL MOUNTED CB INTERCOMPA SYSTEM CALL-IN OR CALL-BACK DEVICE DEFAULT ELEVATION (UNLESS INDICATED OTHERWISE) TO CENTER OF ROUGH-IN: 120" AFF OR 12" BELOW CEILING, WHICHEVER IS LOWER S L INTERCOMPA SPEAKER "L" LOCAL SOUND REINFORCEMENT CEILING MOUNTED DEVICES: VC INTERCOMPA SPEAKER "VC" INDICATES VOLUME CONTROL ON SPEAKER. REFERENCE TECHNOLOGY/SECURITY SHEET FOR ADDITIONAL INFORMATION. ONE-LINE DIAGRAM 800A/3P TRANSFORMER, TYPE AND RATINGS AS NOTED 400A FUSE, RATING AS SHOWN ST SHUNT TRIP GF GROUND FAULT PROTECTION AF ARCH FAULT PROTECTION K KIRK-KEY INTERLOCK M DIGITAL METER OR SUB-METER INTEGRATED INTO EQUIPMENT 1200/5 CURRENT TRANSFORMER, RATED AS SHOWN H GROUND CONNECTION AUTOMATIC TRANSFER SWITCH BUS DUCT PLUG M ELECTRICAL UTILITY REVENUE METER SPD SURGE PROTECTION DEVICE GANN GENERATOR ANNUNCIATOR PANEL CIRCUIT BREAKER DRAW-OUT CIRCUIT BREAKER NEW EQUIPMENT/WIRING DEMOLITION EQUIPMENT/WIRING EXISTING EQUIPMENT/WIRING UNDERGROUND WIRING DAYLIGHT ZONES DAYLIGHT ZONE/PRIMARY SECONDARY DAYLIGHT ZONE DAYLIGHT ZONES SHALL BE INCLUSIVE OF THE FIXTURES WITHIN THE SHADeD REGION, AND SHALL BE DIMMED USING ON-BOARD OR EXTERNAL CONTROL IN ACCORDANCE WITH IECC 2021. IECC 2018 OR 2015 MAY BE REFERENCED ONLY WHERE ADOPTED BY LOCAL AHJ.	MISCELLANEOUS SHADED SYMBOLS INDICATE EXISTING DEVICES TO REMAIN, UNLESS OTHERWISE NOTED. — INDICATES WALL-MOUNTED WHEN ATTACHED TO ANY SYMBOL ① DRAWING NOTE REFERENCE SOS AREA OF RESCUE ASSISTANCE FIRE ALARM WATER FLOW SWITCH SUPEROVISORY SWITCH SMOKE DETECTOR - MULTI CRITERIA DETECTOR SMOKE DETECTOR - SSB INDICATES INTEGRAL SOUNDER BASE. "D" INDICATES DUCT TYPE. "R" INDICATES 120 VOLT RESIDENTIAL TYPE HEAT DETECTOR BEAM DETECTOR TRANSMITTER, HIGH IN CEILING WALL DIRECT LINE OF SIGHT. BEAM DETECTOR RECEIVER, HIGH IN CEILING WALL DIRECT LINE OF SIGHT. FIRE ALARM SPEAKER STROBE / CEILING MOUNTED FIRE ALARM SPEAKER / CEILING MOUNT. MAGNETIC DOOR HOLDER AUXILIARY CONTROL RELAY FIRE FIGHTER HANDSET FIRE ALARM PULL STATION +42" AFF FIREMAN'S TELEPHONE JACK +42" AFF AUDIO VISUAL FIRE ALARM HORN STROBE +80" AFF- 15/75cd U.N.O. VISUAL FIRE ALARM (STROBE) CEILING MOUNT - 15/75cd U.N.O. AUDIO FIRE ALARM HORN +80" AFF FIRE ALARM CONTROL PANEL REMOTE FIRE ALARM ANNUNCIATOR PANEL REMOTE POWER SUPPLY FOR AUDIO/VISUAL FIRE ALARM DEVICES. FIRE SMOKE DAMPER REMOTE LED INDICATOR LIGHT SECURITY ADA AUTO DOOR OPEN BUTTON DOOR RELEASE BUTTON WALL MOUNTED CARD READER REFERENCE TECHNOLOGY/SECURITY SHEET FOR ADDITIONAL INFORMATION. SWITCHES AND LIGHTING CONTROL DEVICES ALL SWITCH TYPES AND SENSORS TYPES FOUND ON LIGHTING CONTROL DEVICE SCHEDULE. LOCATED ON ELECTRICAL SCHEDULE SHEETS SWITCH ANNOTATION AS FOLLOWS: TYPE, PER SCHEDULE NO TYPE INDICATES SINGLE POLE TOGGLE SWITCH \$a,b,c SWITCH LEGS, PER PLAN, SHOWN HERE AS 3 (a,b,c) OCCUPANCY SENSOR ANNOTATION, AS FOLLOWS: OCCUPANCY / VACANCY SENSOR 'X' INDICATES TYPE, PER SCHEDULE CEILING SENSOR WITH BRACKET INDICATES WALL / CORNER MOUNT LIGHT SENSOR ANNOTATION, AS FOLLOWS: PC DIGITAL PHOTOCELL DS DAYLIGHT HARVESTING SENSOR RELAY PANELS, CONTACTORS, TIME SWITCHES: XX RELAY/CONTACTORS/TIMERS/DEVICES WHERE XX INDICATES: "LC" LIGHTING CONTRACTOR "LCP" LIGHTING CONTROL PANEL "TS" TIME SWITCH "TC" TIME CLOCK DRAWING/DETAIL REFERENCE KEY REFER TO DRAWING/DETAIL NUMBER RE: 1 E3-2 SHEET NUMBER 1 E3-2 PANELBOARD NOMENCLATURE 5 DP C H A 1 SUB PANEL AREA VOLTAGE H: 480V/277V L: 208V/120V BRANCH NONE: NORMAL E: LIFE SAFETY Q: EQUIPMENT C: CRITICAL R: LEGALLY REQUIRED X: OPTIONAL STAND-BY DISTRIBUTION PANEL (IF APPLICABLE) LEVEL



E0.01

NEW FIRE STATION #12 CY-FAIR
VOLUNTEER DEPARTMENT HARRIS
COUNTY EMERGENCY SERVICES NO. 9

TBPE Firm
Registration No. 2234

DATE:
03/16/23

DRAWN BY:
DBR

CHECKED BY:
DBR


PROJECT NUMBER
Project Number

SHEET TITLE:
ELECTRICAL SYMBOL
LEGEND

SHEET NUMBER:

1



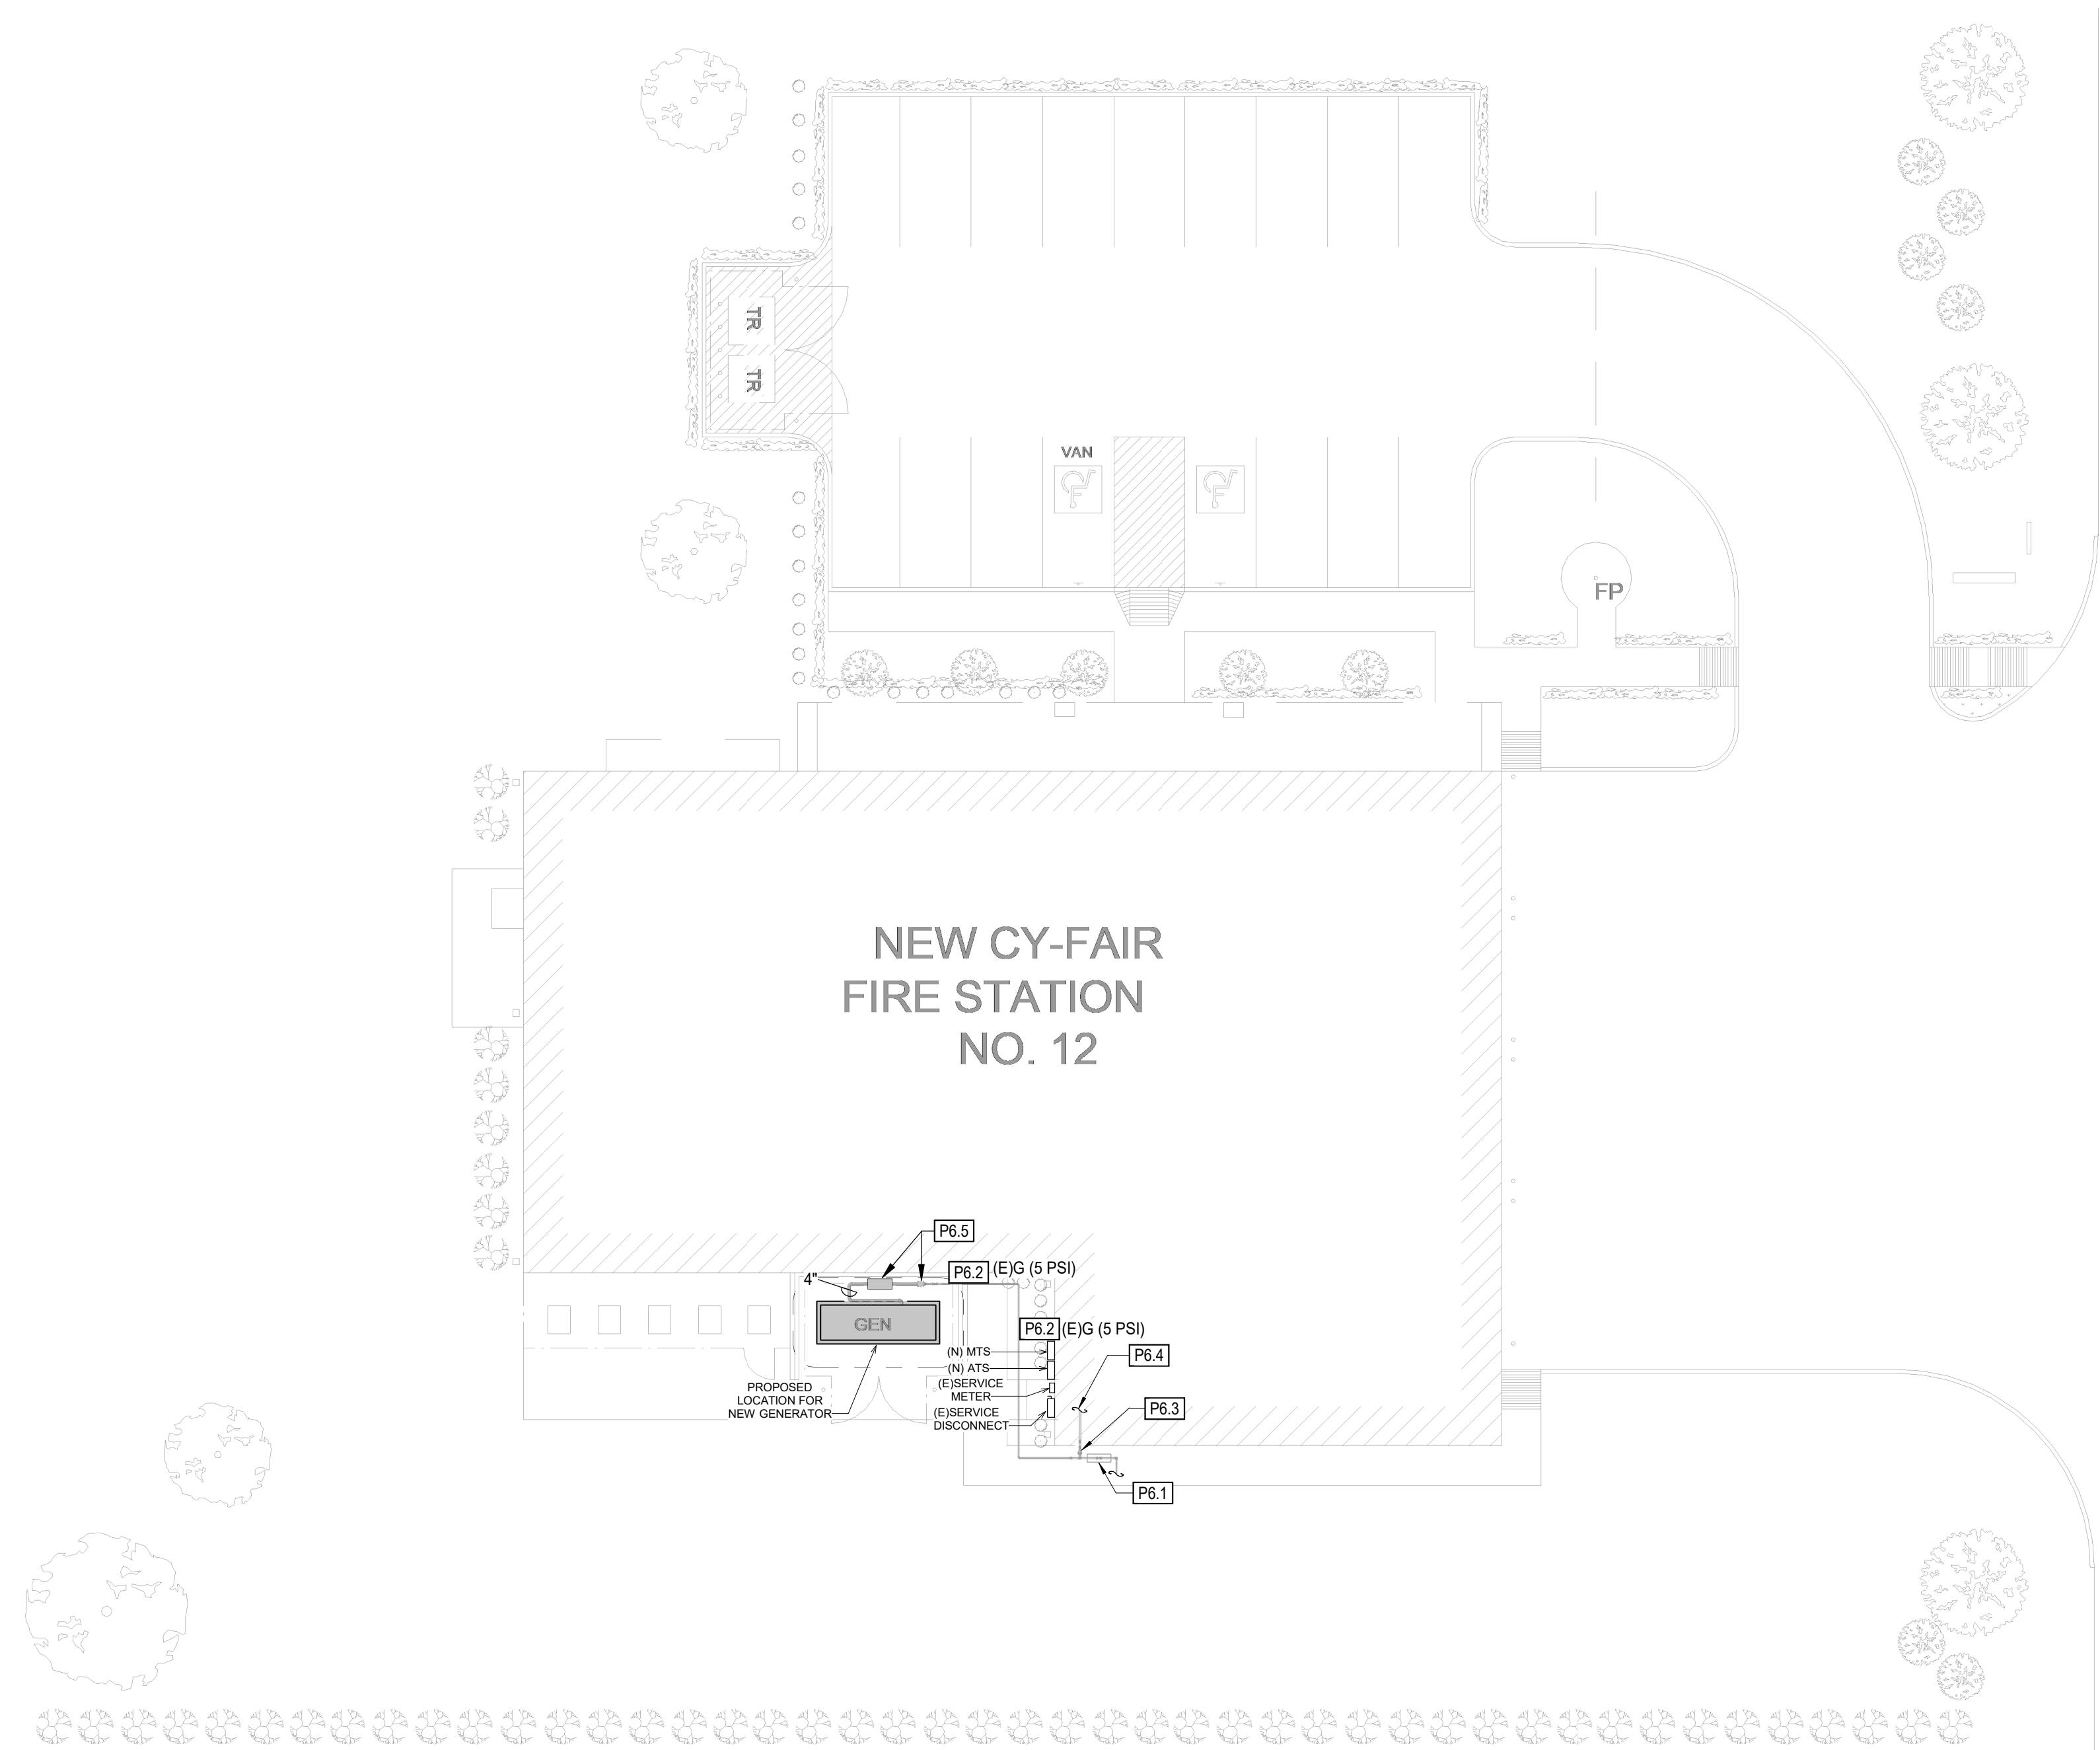

1 PLUMBING SITE PLAN

1/16" = 1'-0"

PLUMBING KEYED NOTES


P6.1 APPROXIMATE LOCATION OF EXISTING GAS METER: 2,603 CFH AT 5 PSI, SHUT-OFF VALVE AND PRESSURE REGULATOR ASSEMBLY. INCREASE IN GAS LOAD OF 460 CFH FOR A NEW TOTAL GAS LOAD OF 3,063 (REFER TO BUILDING GAS LOAD DEMAND TABLE ON SHEET P0.11). LOCAL GAS UTILITY COMPANY HAS BEEN CONTACTED TO DETERMINE IF EXISTING GAS METER REQUIRES REPLACING.

P6.2 EXISTING GAS PIPING TO GENERATOR ROUTED UNDERGROUND FROM GAS METER AND UP THROUGH SLEEVE AT GENERATOR PAD. CONTRACTOR SHALL VERIFY, IN THE FIELD, EXACT LOCATION OF EXISTING GAS PIPING TO GENERATOR.

P6.3 EXISTING GAS PRESSURE REGULATOR SET FROM 5 PSI TO 4 OZ TO REMAIN AND BE REUSED.

P6.4 EXISTING GAS 875 CEH AT 4 OZ TO EXISTING MECHANICAL EQUIPMENT AND

P6.5 EXISTING GAS PRESSURE REGULATOR AND BUFFER TANK TO BE REMOVED AND REPLACED WITH NEW GAS PRESSURE REGULATOR (5 PSI IN, 11" W.C. OUT) AND BUFFER TANK OF EQUAL SIZE (APPROXIMATELY . PROVIDE NEW PIPING FROM GAS PRESSURE REGULATOR OUTLET TO NEW GENERATOR, SIZE AS NOTED ON PLANS. CONTRACTOR SHALL VERIFY MANUFACTURER'S RECOMMENDED PRESSURE(S) PRIOR TO ORDER GAS PRESSURE REGULATOR.

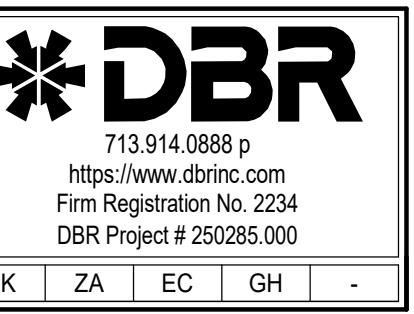

EP.021

NEW FIRE STATION #12 CY-FAIR
VOLUNTEER DEPARTMENT HARRIS
COUNTY EMERGENCY SERVICES NO. 9

TBPE Firm
Registration No. 2234

DATE:

DRAWN BY:
DBR

CHECKED BY:
DBB

PROJECT NUMBER

Project Number

ELECTRICAL AND PLUMBING SITE PLAN

SHEET NUMBER: